

### State of Utah

JON M. HUNTSMAN, JR. Governor

GARY R. HERBERT Lieutenant Governor

### Department of Administrative Services

KIMBERLY K. HOOD Executive Director

Division of Facilities Construction and Management

Director

## ADDENDUM #2

Date: January 3, 2007

To: Consultants

From: David McKay, Project Manager, DFCM

Reference: Utah Science, Technology and Research Initiative (USTAR) Bldg

Utah State University

DFCM Project No. 06292770

Subject: Addendum No. 2

2 **Pages** Addendum page

Architectural Floor Plans 3 page Total 5 pages

Note: This Addendum shall be included as part of the Contract Documents. Items in this Addendum apply to all drawings and specification sections whether referenced or not involving the portion of the work added, deleted, modified, or otherwise addressed in the Addendum. Acknowledge receipt of this Addendum in the space provided on the Bid Form. Failure to do so may subject the Bidder to disqualification.

1.1 SCHEDULE CHANGES – There are no schedule changes per this addendum.

### 1.2 **GENERAL**

1. The Selection Committee Members are:

**Ted McAleer, Executive Director, USTAR Governing Authority** Hunter Jackson, Ph.D. Board Member, USTAR Governing Authority Jack Sunderlage, Board Member, USTAR Governing Authority Ned M. Weinshenker, Ph.D. VP for Strategic Ventures & Economic Development Stanley Kane/Jordy Guth, USU Facilities & Planning Jeff Broadbent, Associate VP for Research Keith Stepan, Director, DFCM

2. Access to an earlier 'Study' of a related project was mentioned during the mandatory meeting. After further consideration it has been decided that the earlier related 'Study' would contribute little and might even be misleading. Therefore, the earlier 'Study' will not be released by USU.



3. USU, in order to meet their USTAR contribution obligation, is proposing for Legislative approval the donation of the USU Research Foundation Building on the Innovation Campus at the corner of 600 East and Grand Avenue. This approximately 25,000gsf facility completed in about 2004-05 includes sophisticated lab space (BSL-3 and vibration isolated), office space, lobby and hospitality areas, with some shelled space. How this facility would work with an overall guiding concept will be one of the challenges that selected programming firm will be asked to meet. This existing building will obviously affect the general site design of the entire project. PDF's of the floor plans are attached.

### End of Addendum #2



THE MERGER OF JENSEN HASLEM AND THOMAS PETERSEN HAMMOND

ARCHITECTS EFFECTIVE JANUARY 1, 2003

Architectural NEXUS, East Office

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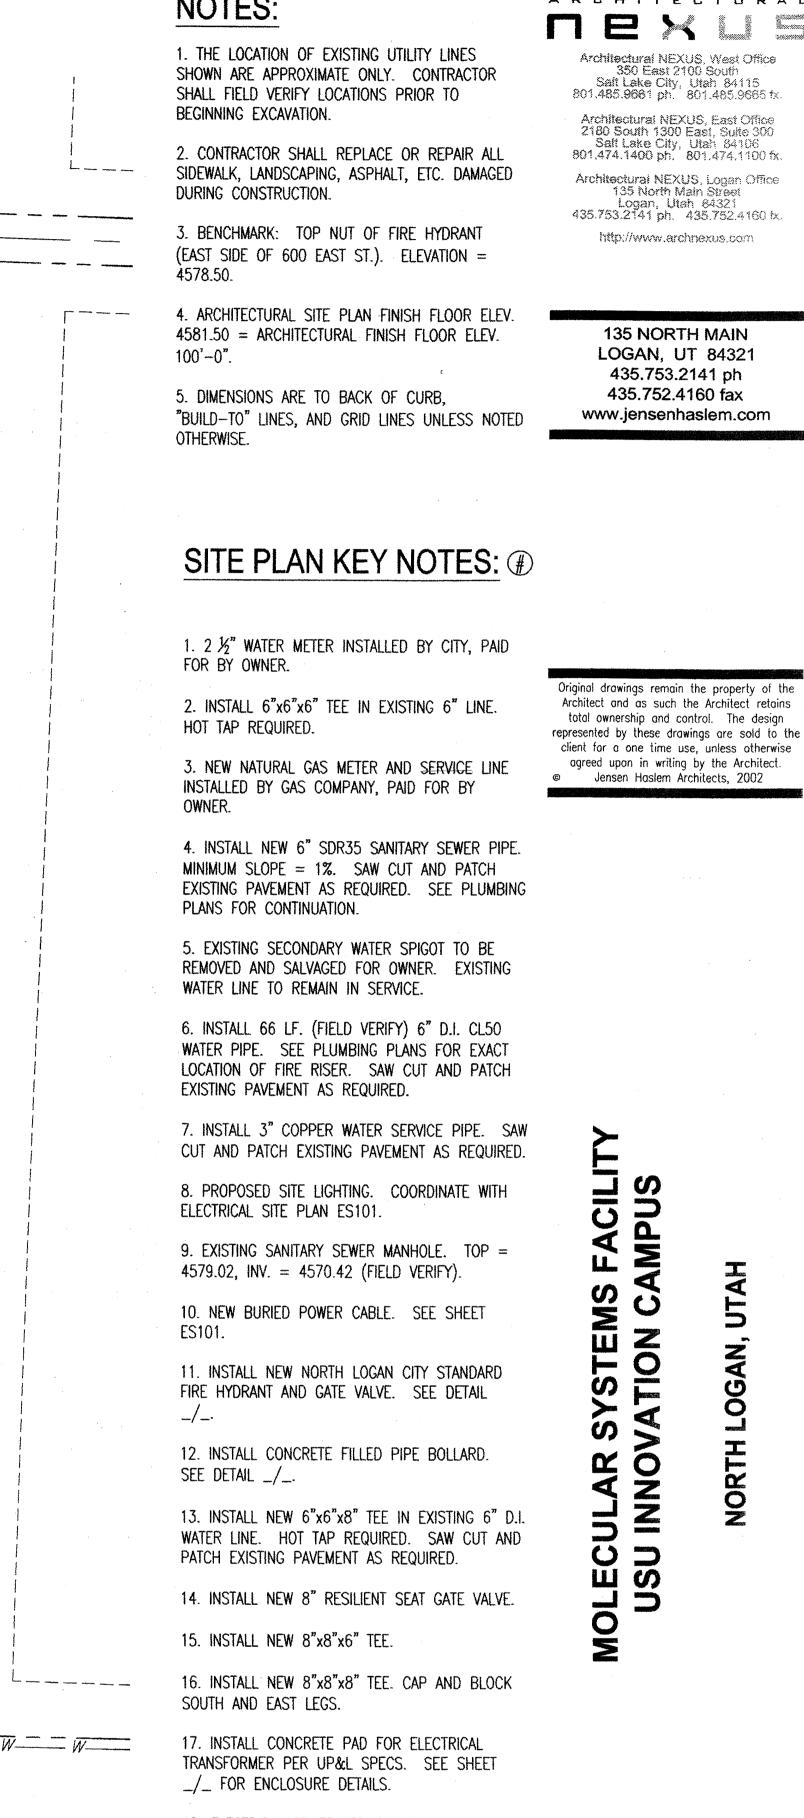
135 NORTH MAIN

LOGAN, UT 84321

435.753.2141 ph

435.752.4160 fax

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SITE PLAN GENERAL NOTES:

18. ELECTRICAL GENERATOR ENCLOSURE. SEE

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SHEET \_/\_ FOR ENCLOSURE DETAILS. 19. INSTALL NEW OIL/WATER SEPARATOR. SEE DETAIL \_/\_.

20. INSTALL CONCRETE POLYMER TRENCH DRAIN. CONNECT OUTLET TO NEW 6" PERFORATED

FOOTING DRAIN. 21. INSTALL NEW CLEAN-OUT TO GRADE. SEE DETAIL \_/\_.

SITE GRADING PLAN

CATCH BASIN TABLE

4579.19

4578.99 4575.48

<u>FLOWLINE</u> <u>ELEVATION</u>

4579.60 4575.10 4575.40(E)

4575.86 4546.06(S,W)

4575.27 4576.00(S)

4573.57 4573.77(S) 4572.12 4572.32(S,E) 4571.16 4571.40(E)

4570.24 4570.44(S)

4574.40

4576.39

4574.93

**ELEVATION** 

' <u>Grate</u> <u>Elevation</u>

NOTE: TRAFFIC RATED SOLID COVERS ON C.B.#9, #10, #11, #12

<u>CATCH BASIN</u> <u>SIZE</u>

4 x 2

4 x 2

2 x 2

4 x 2

3 x 3

LEGEND

NEW CONCRETE FLATWORK

EXISTING SANITARY SEWER LINE

EXISTING IRRIGATION/DRAINAGE

PROPOSED DRAINAGE PIPE LINE

EXISTING NATURAL GAS LINE

PROPOSED NATURAL GAS LINE

EXISTING COMMUNICATIONS LINE

EXISTING FIRE HYDRANT

PROPOSED FIRE HYDRANT

EXISTING SEWER MANHOLE

EXISTING WATER VALVE

PROPOSED WATER VALVE

PROPOSED WATER METER

PROPOSED GAS METER

PROPOSED LIGHT POLES

PROPOSED SEWER MANHOLE

PROPOSED CLEAN-OUT TO GRADE

EXISTING UNDERGROUND POWER LINE

PROPOSED UNDERGROUND POWER LINE

(C.B.#9)

90 LF. 12" HDPE PIPE

S = 0.70%

(C.B.#8)

(C.B.#7)

(C.B.#6)

Finish Floor

Elevation = 4581.50

65 LF. 6" PERF. HDPE PIPE — S = 1.07%

65 LF. 6" PERF. HDPE PIPE S = 4.49%

(Finish Floor

Elevation =

4579.75)

Existing Natural Gas

 $\sim$  22 LF. 10" HDPE PIPE S = 1.50%

\$600 EAST STREET

Existing Secondary Water

PROPOSED SANITARY SEWER LINE

NEW ASPHALT PAVING


EXISTING WATER LINE

PIPE LINE

JHA PROJECT # CHECKED BY: DRAWN BY: CURRENT/BID DATE: 3.28.03 SHEET CONTENTS

REVISIONS

**SITE UTILITIES PLAN** 

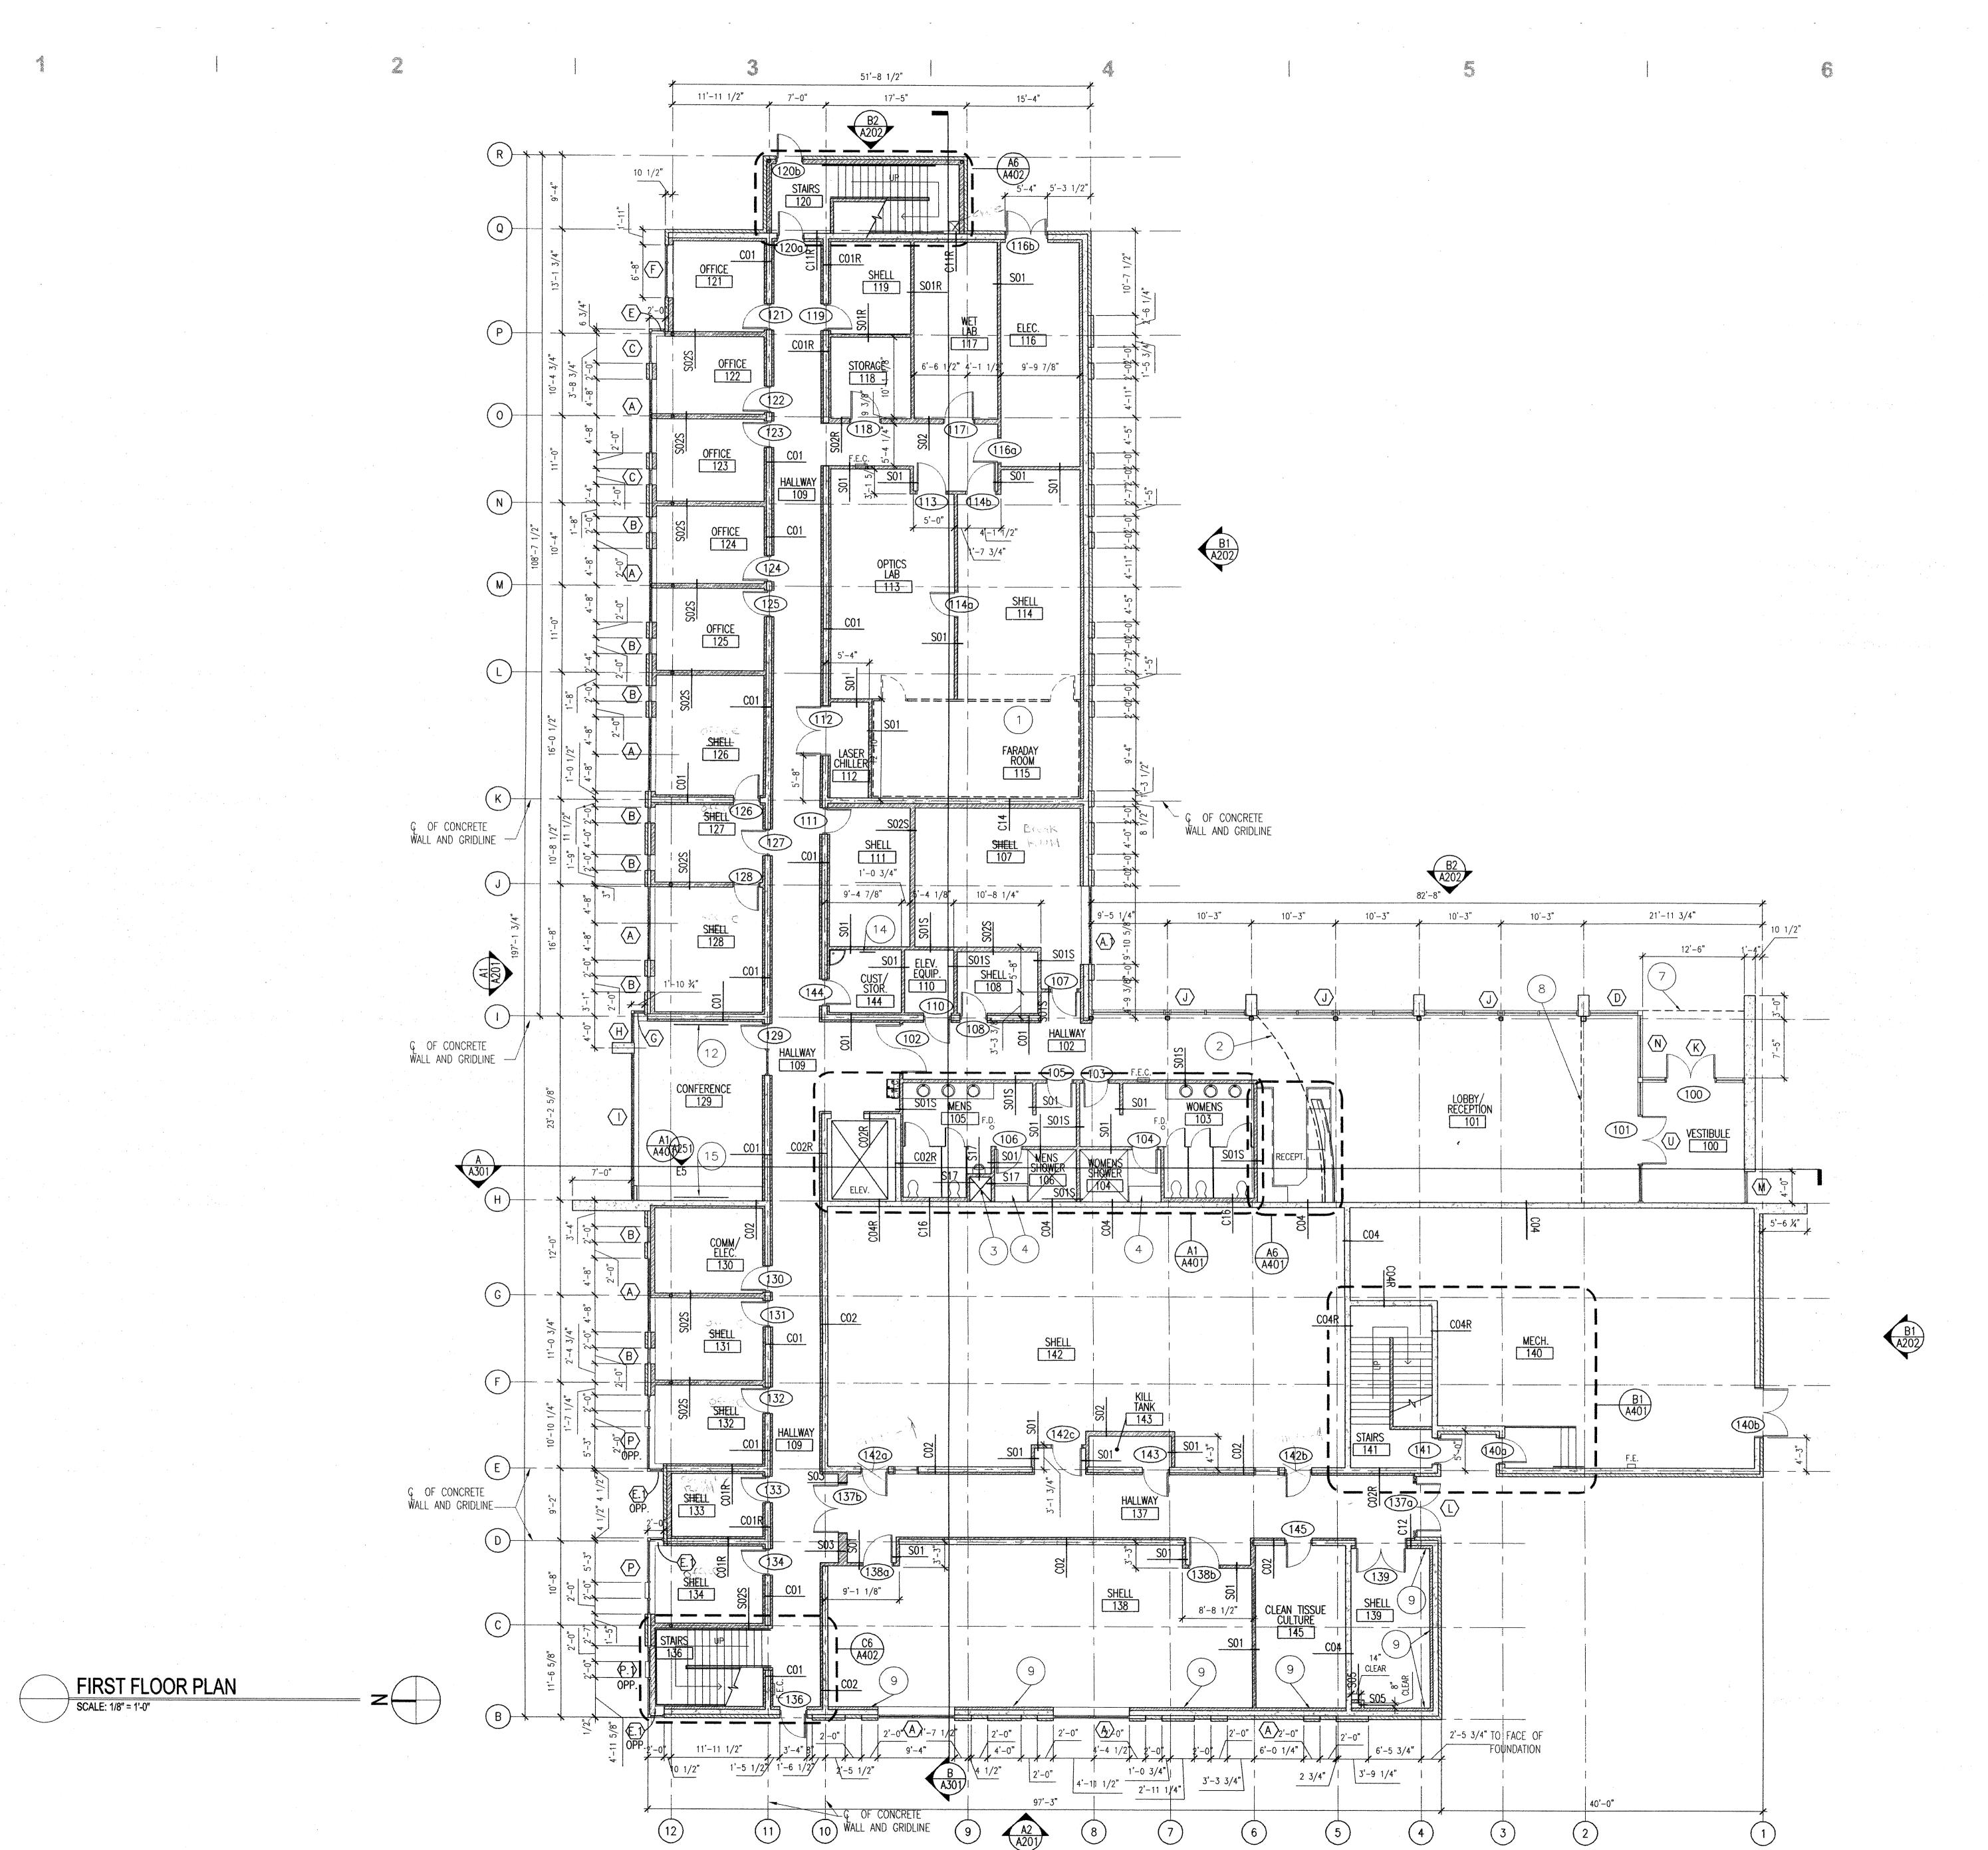

# FLOOR PLAN GENERAL

1. EXTERIOR DIMENSIONS ARE TO THE FACE OF FOUNDATION, GRID LINE OR BRICK/ FOUNDATION BUMP OUT. INTERIOR DIMENSIONS ARE TO FACE OF FINISHED WALL OR GRIDLINE. REFER TO THE FOLLOWING FOUNDATION DETAILS FOR GENERAL RELATIONSHIP OF FACE OF FOUNDATION WALL TO EXTERIOR FINISH WALL

BRICK VENEER FACE OF EXTERIOR SHEATHING OR FACE OF CONCRETE FACE OF FOUNDATION WALL

FACE OF EXTERIOR SHEATHING OR FACE OF CONCRETE FACE OF FOUNDATION WALL

FACE OF ALUMINUM CURTAINWALL OR STOREFRONT SYSTEM FACE OF FOUNDATION WALL

2. DO NOT SCALE DRAWINGS.

3. SEE CIVIL, STRUCTURAL, MECHANICAL AND ELECTRICAL DRAWINGS FOR MORE INFORMATION.

4. SEE SHEET A401 FOR TYPICAL ACCESSIBILITY CLEARANCE AND COMPLIANCE REQUIREMENTS.

5. PROVIDE BACKING BEHIND ALL SURFACE MOUNTED EQUIPMENT AND/OR FIXTURES PER

6. SEE SHEET A101 FOR EXTERIOR DIMENSIONS

8. REFER TO SHEETS A602 AND A603 FOR

9. REFER TO SHET GOO3 FOR WALL TYPES.

## FLOOR PLAN KEY NOTES: #

1. FARADAY ROOM TO BE RELOCATED FROM EXISTING LOCATION AND INSTALLED AT LOCATION

2. LINE OF FLOOR ABOVE

3. CHASE.

4. LOCKER/ SHOWER ROOM BENCH.

5. COLD ROOM TO BE RELOCATED FROM EXISTING LOCATION AND INSTALLED AT LOCATION SHOWN.

6. THRU-WALL AUTOCLAVE. PROVIDE HOLLOW METAL FRAME WITHOUT STOP COMPLETELY AROUND OPENING.

7. LINE OF SOFFIT ABOVE.

8. LINE OF WINDOW SYSTEM ABOVE.

9. NO GYPSUM BOARD ON EXTERIOR WALLS IN SHELL SPACES. INSTALL STUDS & INSULATION.

10. ROOF ACCESS HATCH (ABOVE)

11. DOUBLE TIER LOCKERS

12. 4' x 8' MARKER BOARD.

13. ROOF ACCESS LADDER - COORDINATE WITH ROOF ACCESS HATCH & SHOP EQUIPMENT.

14. MOP & BROOM HOLDER. SEE ACCESSORY KEYNOTE 3 ON SHEET A401 FOR MOUNTING

15. PROJECTION SCREEN - CEILING MOUNTED

16. PROVIDE HOLLOW METAL FRAME WITHOUT STOP COMPLETELY AROUND OPENING.

17. PREFABRICATED SHIPS LADDER AND LANDING WITH HANDRAIL

<u>ABREVIATIONS</u>

E.W.C. ELECTRIC WATER COOLER F.E.C. FIRE EXTINGUISHER CABINET F.E. FIRE EXTINGUISHER & MOUNTING BRACKET. (SEE SHEET A401 FOR MOUNTING HEIGHTS.)

NOTES:

BRICK VENEER

DETAIL B3/A701.

NOT NOTED ON ALL FLOOR PLAN SHEETS.

7. REFER TO SHEET A121 FOR ROOF SLOPES, ROOF DRAINAGE AND OTHER ROOF EQUIPMENT.

WINDOW TYPES.

THE MERGER OF JENSEN HASLEM AND THOMAS PETERSEN HAMMOND ARCHITECTS EFFECTIVE JANUARY 1, 2003

ARCHITECTURAL

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Architect and as such the Architect retains

total ownership and control. The design represented by these drawings are sold to the client for a one time use, unless otherwise

agreed upon in writing by the Architect.

REVISIONS

JHA PROJECT #: CHECKED BY: B. Hardcastle DRAWN BY: CURRENT/BID DATE: 3.28.03

SHEET CONTENTS FIRST FLOOR PLAN

## FLOOR PLAN GENERAL NOTES:

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FACE OF ALUMINUM CURTAINWALL OR STOREFRONT FACE OF FOUNDATION WALL

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5. PROVIDE BACKING BEHIND ALL SURFACE MOUNTED EQUIPMENT AND/OR FIXTURES PER DETAIL B3/A701.

6. SEE SHEET A101 FOR EXTERIOR DIMENSIONS NOT NOTED ON ALL FLOOR PLAN SHEETS.

7. REFER TO SHEET A121 FOR ROOF SLOPES, ROOF DRAINAGE AND OTHER ROOF EQUIPMENT.

8. REFER TO SHEETS A602 AND A603 FOR WINDOW TYPES.

9. REFER TO SHET GOO3 FOR WALL TYPES.

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6. THRU-WALL AUTOCLAVE, PROVIDE HOLLOW METAL FRAME WITHOUT STOP COMPLETELY AROUND

9. NO GYPSUM BOARD ON EXTERIOR WALLS IN SHELL SPACES. INSTALL STUDS & INSULATION.

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Original drawings remain the property of the Architect and as such the Architect retains total ownership and control. The design represented by these drawings are sold to the client for a one time use, unless otherwise agreed upon in writing by the Architect. Jensen Haslem Architects, 2002

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# FLOOR PLAN KEY NOTES: #

CHASE.

LOCATION AND INSTALLED AT LOCATION SHOWN.

7. LINE OF SOFFIT ABOVE.

8. LINE OF WINDOW SYSTEM ABOVE.

10. ROOF ACCESS HATCH (ABOVE)

14. MOP & BROOM HOLDER. SEE ACCESSORY KEYNOTE 3 ON SHEET A401 FOR MOUNTING

15. PROJECTION SCREEN - CEILING MOUNTED

17. PREFABRICATED SHIPS LADDER AND LANDING WITH HANDRAIL.

JHA PROJECT#: CHECKED BY: DRAWN BY:

CURRENT/BID DATE: SHEET CONTENTS **SECOND FLOOR PLAN** 

SECOND FLOOR PLAN SCALE: 1/8" = 1'-0"